
Quality of Work: All work carried out must comply with: Building Code of Australia to the extent required under Environmental Planning Assessment Act 1979, all other relevant codes, standards and specifications that the work is required to comply with under any law and the conditions of any relevant development consent or complying development certificate and any construction certificate.

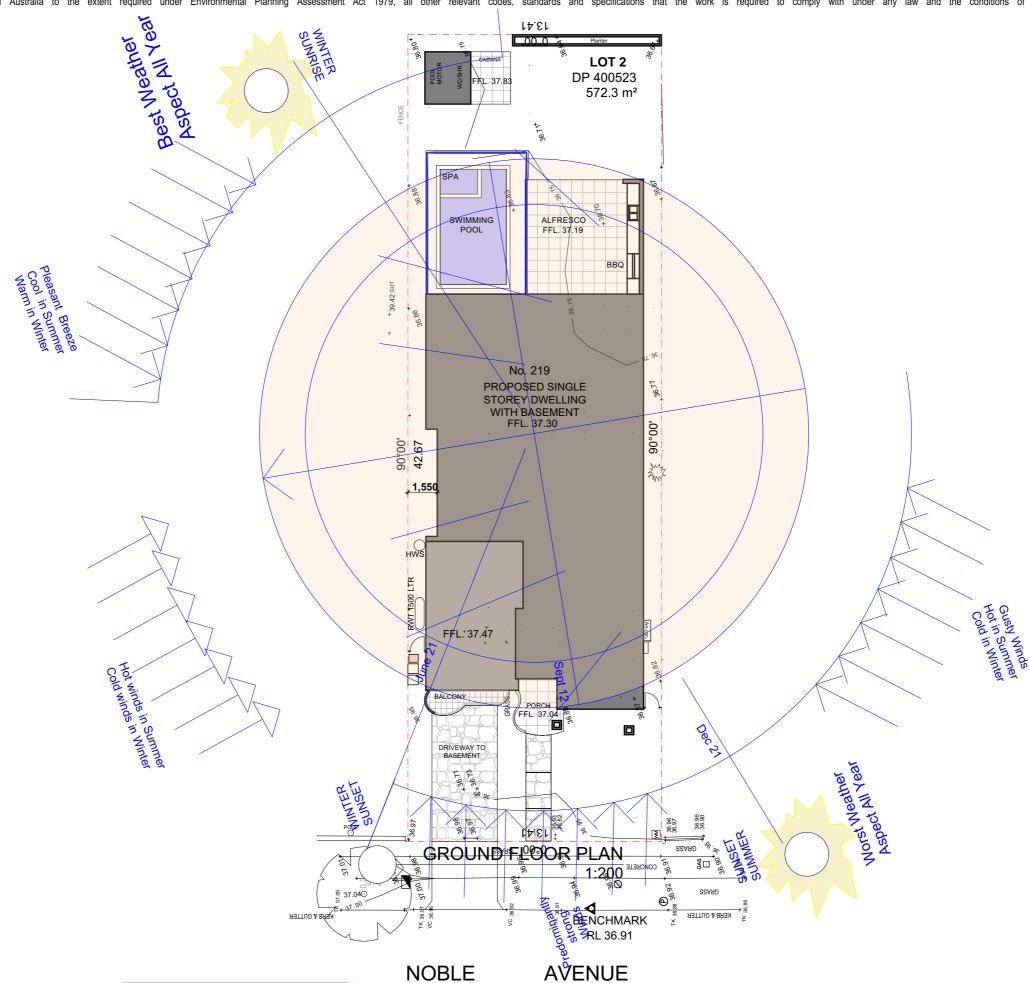

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# **AVENUE**

PROPOSED SINGLE STOREY DWELLING		
Client	Address	Sca
Mr and Mrs Khadem	219 NOBLE AVENUE GREENACRE	Issi


е:	SITE ANALYSIS	
	1:200	


Drawing No.: 219 nobleave 23/05/24 Sheet Number:


С

# SEDIMENTATION CONTROL NOTES

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- 2. DRAINAGE WORKS SHALL BE CONSTRUCTED AROUND ALL INLET PITS, CONSISTING OF 300MM W X 300MM D TRENCH.
- 3. ALL SEDIMENT BASINS AND TRAPS SHALL BE CLEANED WHEN AT A MAXIMUM OF 60% FULL OF SOIL MATERIALS.
- 4. ALL DISTURBED AREAS SHALL BE REVEGETATED AS SOON AS THE RELEVANT WORKS ARE COMPLETED.
- 5. SOIL AND TOPSOIL STOCKPILES SHALL BE LOCATED AWAY FROM DRAINAGE LINES AND AREAS WHERE WATER MAY CONCENTRATE.
- 6. FILTER SHALL BE CONSTRUCTED BY STRETCHING A FILTER FABRIC (PROPEX OR EQUIVALENT) BETWEEN POSTS AT 2M CENTRES. FABRIC SHALL BE BURIED 200MM ALONG THE BOTTOM EDGE.

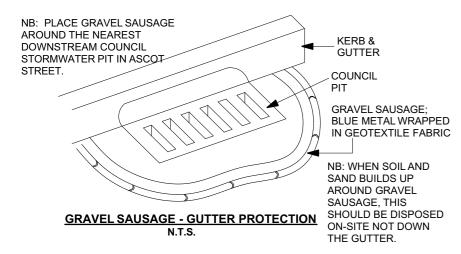

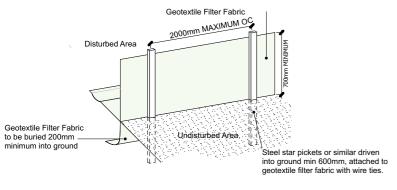

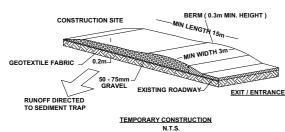


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# **DEMOLITION WORK NOTE:**

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# Construction Management Plan

The following Construction Management Plan will highlight the following: -Location of material storage.

-Location of any plant & equipment (cranes, hoists.etc)

-Maximum intended weight and size of construction and delivery vehicles -Intended timing of deliveries to site

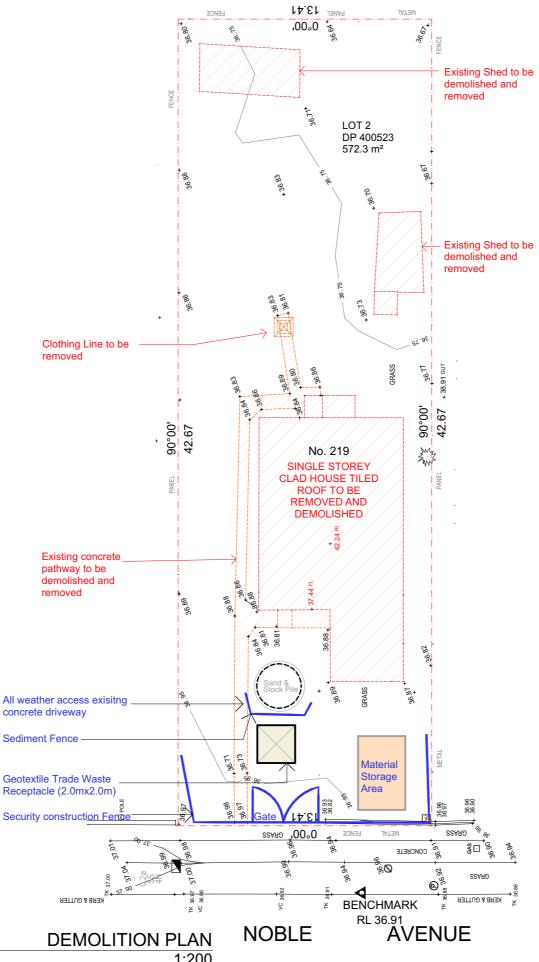-Contact details for of person with authority to respond to any construction related

-Intended communication of construction details to adjoining residents

-Details of any signage to be erected on the site

# Location of any plant or equipment

Plant and equipment (cranes, hoists, rubbish bins etc) will be located in Location "B" (front yard) to avoid damage to existing established landscape to the rear of the

NOTE - Use of plant & equipment is to be timed so that material storage does not interfere with locating plant or equipment in the required area.

# Construction and delivery vehicles

Construction vehicles will generally take the shape of trade utes/vans. Delivery vehicles are to be of fixed tray type with maximum weight of 3 tonnes. Concrete delivery is to be in the more of mini-mix vehicle. Rubbish bins are to be limited to 4 cubic metre bins during demolition stage and reduced to 3 cubic metre bins for general site cleaning as necessary.

# Vehicle access and egress

Construction vehicles (utes/vans) can access and egress the site without any special requirements. Delivery trucks are not to enter the site and must stay on the public, road to avoid damage to road crossing, footpath and or driveway.

# Material delivery and handling

Materials delivered to site are to be unloaded from delivery truck on site wherever possible and stored in appropriate location as specified immediately. Where unloading is not possible on site materials are to be unloaded at street level and manually carried onto site and stored in appropriate locations as specified immediately.

NOTE- At no time are materials to be stored on the road, access handle, nature strip or adjoining properties.

# Hours of Work

All Construction /Demolition work relating to the Development Consent within the city must be carried out between the hours of 7:00am to 5:00pm Mondays to Fridays and 7:00am to 12:00 noon on Saturday. No work is to be done on Sunday and Public Holidays, Refer Council's DA Determination Notes.

# Timing of deliveries

Material deliveries will generally take place between 8:00am and 3:00pm the day before the materials will be required on site.

# Communication with adjoining residents

Upon receipt of the Construction Certificate the adjoining residents will be notified that works are being arranged to begin. This will provide approximately 3 weeks' notice in this regard. This notification will include all contact details per above. Further to this the Construction Supervisor will introduce himself to these residents a minimum of 48 hours prior to commencement.

# Location of Material Storage

Materials will be stored on site in locations marked or shown Below: Location marked = (side access for proposed driveway) heavy/bulky materials such as bricks/steel/roof tiles etc will be stored in this area in order to allow lifting off delivery truck and placement for storage without "double handling" of materials. Timber/Pre-Fabricated frames and trusses etc will be stored on the front lawn. These materials are generally of longer lengths and light enough to allow manual handling from delivery truck to storage area.

Location "C" - New floor platform- internal finishing materials

(Skirting/architraves/doors etc\_ will be stored internally within the new area as directed by the builder for protection from weather. Fragile materials such as tiles, plumbing fittings and fixtures etc will be stored in the old study/bedroom area o r rooms not generally used by the proprietors so as to minimize possibility of damage and to provide security against theft.

NOTE - Material deliveries are to be timed so that only materials required for the scope of works to be carried out at that stage are on site in order to ensure the site is not cluttered and to allow easy

### access for trades/residents to and from the site. Signage

Signage in the form of a site sign to identify the Builder's and Architects names and contact details and the Principal certifying Authority will be required on site. The location of this signage is shown on the associated plans

# Soil & Water Management Plans

All sediment controls are to be installed before work commence. Any areas of exposed soil are to be minimised. All top-soil is to be retained on site for re-use. Material & soil stockpiles are to be protected sediment fencing. Stockpiles and work areas are to be as indicated by the Construction Management Plan to preserve existing vegetation. Surface water flows during construction are to be controlled as

Clean run off is to be diverted around disturbed areas

Disturbed areas are to be promptly rehabilitated

Sediment fence are to be regularly monitored and manufactured during construction. Slope gradient & flow distance are to be minimised





# PROPOSED SINGLE STOREY DWELLING Sheet Title: DEMOLITION PLAN Client

Mr and Mrs Khadem

219 NOBLE AVENUE **GREENACRE** 

1:200

Issue

C

Drawing No.: 219 nobleave

Sheet Number: 2

23/05/24

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LISED ABOVE CONTACT ADAM NASSER 0435237853

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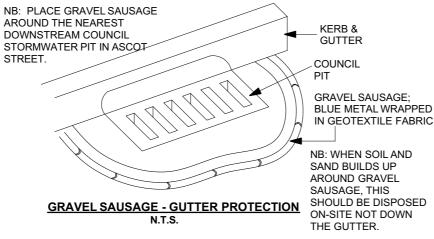
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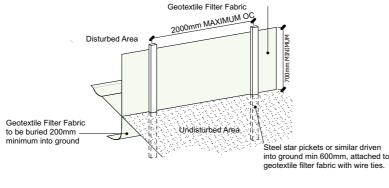
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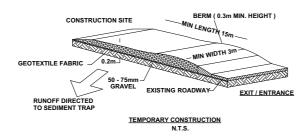
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SPA SWIMMING POOL ALFRESCO FFI 37 19 BBQ SOF 39.22 LOT 3 DP 400523 No. 221 SILL 38.07 DOUBLE STOREY RENDER HOUSE No. 219 S1LL 37.43 METAL ROOF PROPOSED SINGLE STOREY DWELLING WITH BASEMENT 98.88 FOS 38.50 SILL FFL. 37.30 84.85 FOS SILL 38.37 38.70 SILL 37.20 ,00°06 39.53 SOF 02.68 SINGLE STOREY BRICK HOUSE 38.45 TILE ROOF No 217 39.60 SOF 1118 8T.14 39.45 SOF 771S 1.15.00 FFL. 37.47 LOT 1 DP 659297 CARPORT PORCH BALCONY PORCH\_ DRIVEWAY TO **NEW VEHICULAR** BASEMENT ONSITE **CROSSING TO** COUNCIL **SPECIFICATIONS** Security construction Fence SA⊡ CONCRETE ا ا **CRASS** (a) KERB & GUTTER BENCHMARK RL 36.91 SEDIMENT CONTROL PLAN 1:200 **NOBLE AVENUE** 

SEDIMENT CONTROL PLAN

1:200

C

Issue

3.41 0°00

**SAND BAGGING** 

SEDIMENT FENCE

METAL SECURITY

FENCE

PROPOSED SINGLE STOREY DWELLING

219 NOBLE AVENUE

**GREENACRE** 

LOT 2

DP 400523

572.3 m<sup>2</sup>


MERRETT STREET

Drawing No.: 219 nobleave

Sheet Number: 3

23/05/24

PERGOLA

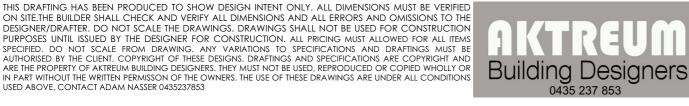



Client

Mr and Mrs Khadem



DESIGNER/DRAFTER. DO NOT SCALE THE DRAWINGS. DRAWINGS SHALL NOT BE USED FOR CONSTRUCTION PURPOSES UNTIL ISSUED BY THE DESIGNER FOR CONSTRUCTION. ALL PRICING MUST ALLOWED FOR ALL ITEMS SPECIFIED DO NOT SCALE FROM DRAWING ANY VARIATIONS TO SPECIFICATIONS AND DRAFTINGS MUST BE AUTHORISED BY THE CLIENT. COPYRIGHT OF THESE DESIGNS. DRAFTINGS AND SPECIFICATIONS ARE COPYRIGHT AND ARE THE PROPERTY OF AKTREUM BUILDING DESIGNERS. THEY MUST NOT BE USED, REPRODUCED OR COPIED WHOLLY OR IN PART WITHOUT THE WRITTEN PERMISSON OF THE OWNERS. THE USE OF THESE DRAWINGS ARE UNDER ALL CONDITIONS

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# **ENVIRONMENTAL SITE MANAGEMENT NOTES**

- All existing trees to be retained unless shown otherwise on approved Architect's or Landscape drawings. Trees retained are to be protected with a high visibility fence, plus flagging to individual trees as necessary.
- · Retain all existing grass cover wherever possible.
- Sediment and erosion controls must be in place prior to the commencement of any earthworks of demolition activity.
- Install temporary sediment barriers to all inlet pits likely to collect silt laden water, until surrounding areas are paved or regrassed.
- · All silt fences and barriers are to be maintained in good order and regularly desilted during the construction period.
- It is the responsibility of the contractor to ensure that all measures are taken during the course of construction to prevent sediment erosion and pollution of the downstream system. Supervising engineer should be contacted if in doubt.
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- Waste materials are to be stockpiled or loaded into Utility vehicles located as shown on plan.
- · stockpiles of loose material such as sand, soil, gravel must be covered with geotextile silt fence material. Plastic sheeting or membrane must not be used. Safety barricading should be used to isolate stockpiles of solid materials such as steel reinforcing, formwork, scaffolding.
- All vehicles leaving the site must pass over the 'ballast' area to shake off site clay and soil. If necessary wheels and axles are to be hose down. Ballast is to be maintained and replaced as necessary during the construction period.
- Delivery and other motor vehicles removing excavated material should travel on stabilised construction paths and material should be taken to the truck to reduce truck movement on the site.
- · Any sediment deposit on the public way, including footpath reserve and road surface, is to be removed immediately.
- Provide barriers round all construction works within the footpath area to provide safe access for pedestrians.
- Concrete pumps and cranes are to operate from within the ballast entry driveway area and are not to operate from the public roadway unless specific council permission is obtained.
- delivery vehicles must not stand within the public roadway for more than 20 minutes at a time.
- Any excavation work adjacent to adjoining properties or the public roadway is not to be commenced until the structural engineer is consulted and specific instructions received from the engineer
- · Toilet facilities must be either a flushing type or approved portable chemical closet. Chemical closets are to be maintained and serviced on a regular basis so that offensive odour is not emitted.

# SEDIMENTATION CONTROL NOTES

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Soil Management
All excess soil on site generated as a result of necessary excavations to be reused as fill to sub base of raft slab and to achieve a levelled building platform.

Termite Protection Note Kordon Termite Barrier to be installed to perrimeter of building and to all drainage pipe penetrations

Soil Note Slab Level to form Datum to be Determined on Site & to Existing FFL Retaining walls to be completed to engineers details (if required) Sewer connection to Existing Connection Dish drains (if Needed) to Authorities Details Smoke Alarms to be Mains Connected There are no existing trees to be removed.

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# Areas: Basement Floor......154.80m<sup>2</sup> Ground Floor ......216.70m<sup>2</sup> Outbuilding Pool Motor, WC/Shr.....5.80m<sup>2</sup>

# Total internal Floor Area.....


POOL TERRACE AREA	
Alfresco	38.00m <sup>2</sup>
Front Balcony	3.60m2
Front Porch	13.50m <sup>2</sup>
Pool/Spa Area	21.35m <sup>2</sup>


### SITE COVERAGE:

Site Area	572.30m <sup>2</sup>
Landscape (Front) Area	
Landscape (Total) Area	
Private Open Space	
(Includes Pool, Alfresco and Cabana Area)	

# **DESIGN CRITERIA:**

Floor Space Ratio ......216.70m<sup>2</sup> 37.80%

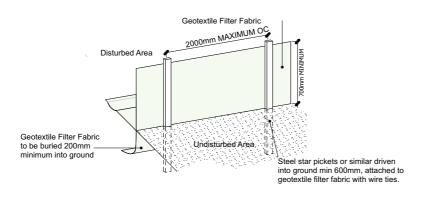

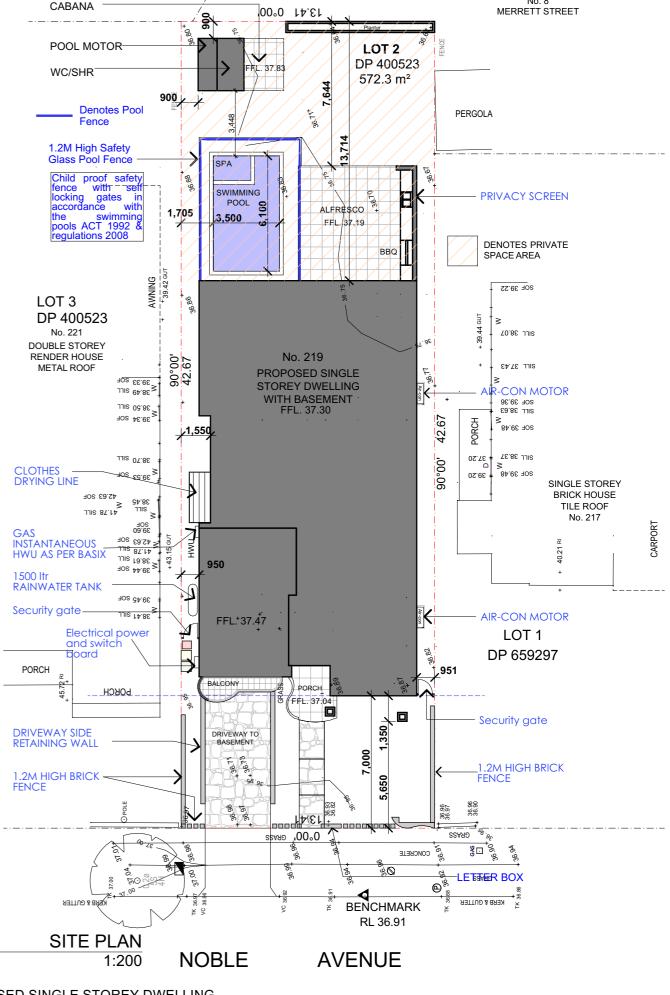






PROPOSED SINGLE STOREY DWELLING

**GREENACRE** 

219 NOBLE AVENUE Issue C

Sheet Title: SITE PLAN Drawing No.: 219 nobleave 1:200 23/05/24

Sheet Number:

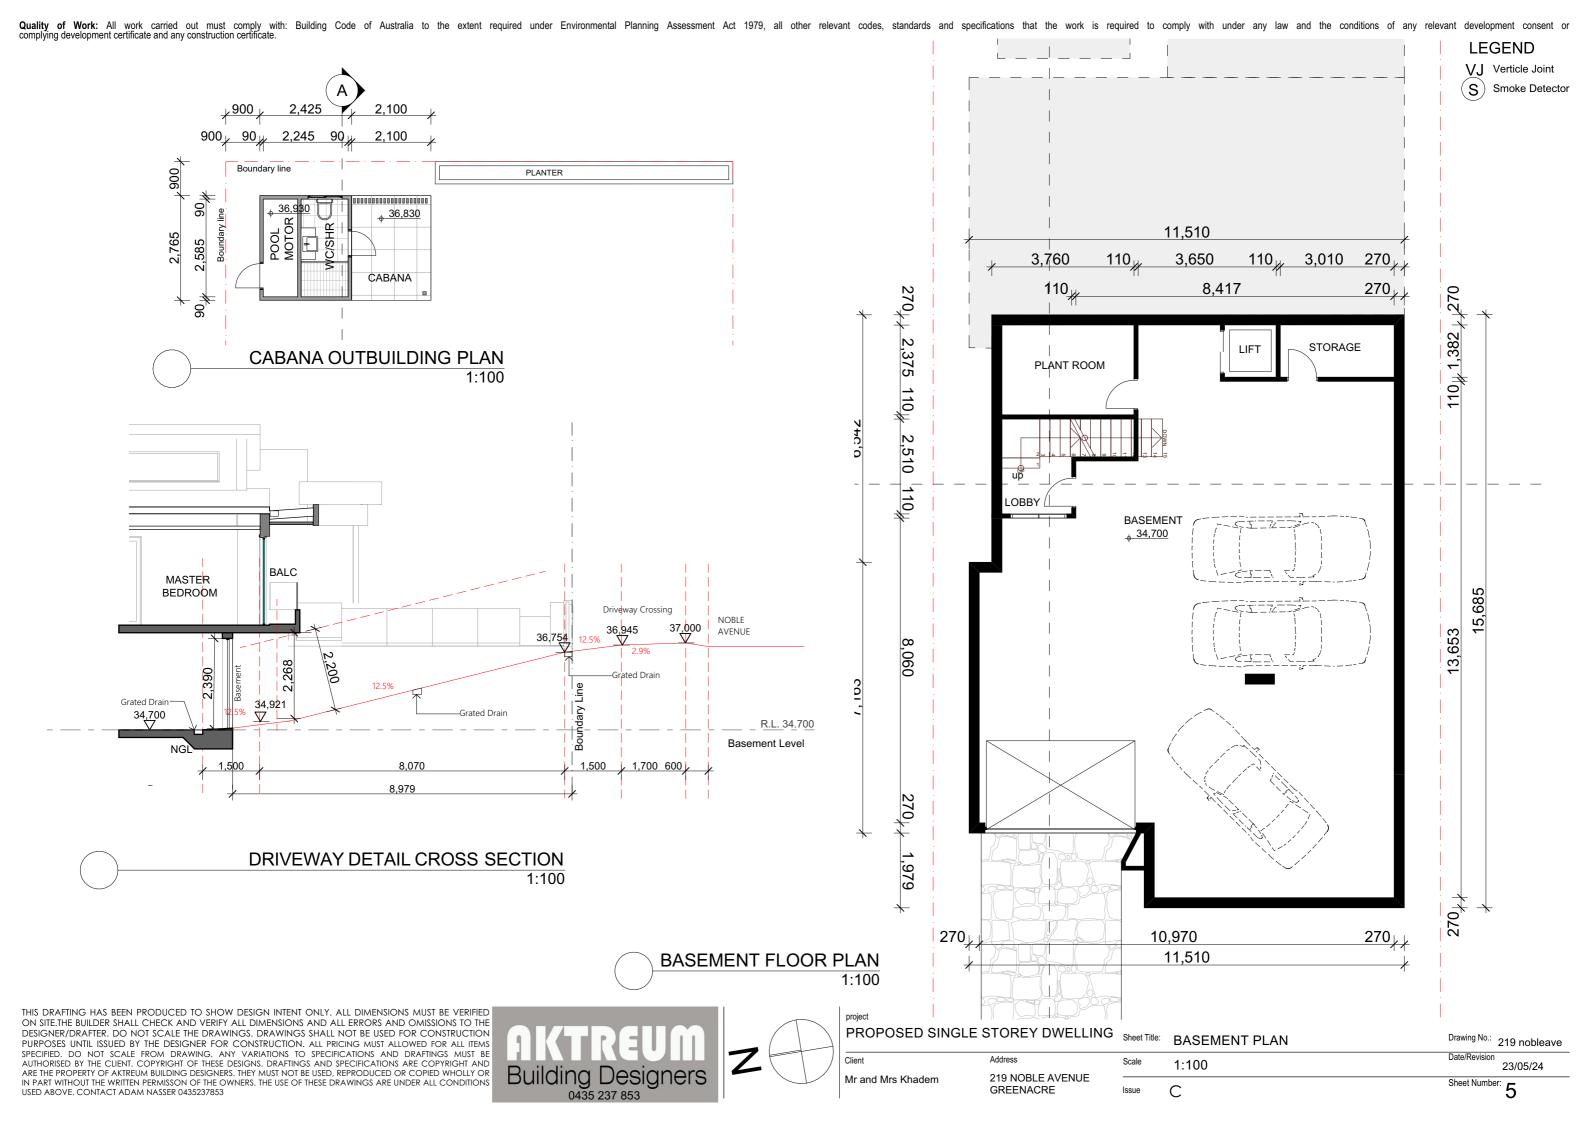

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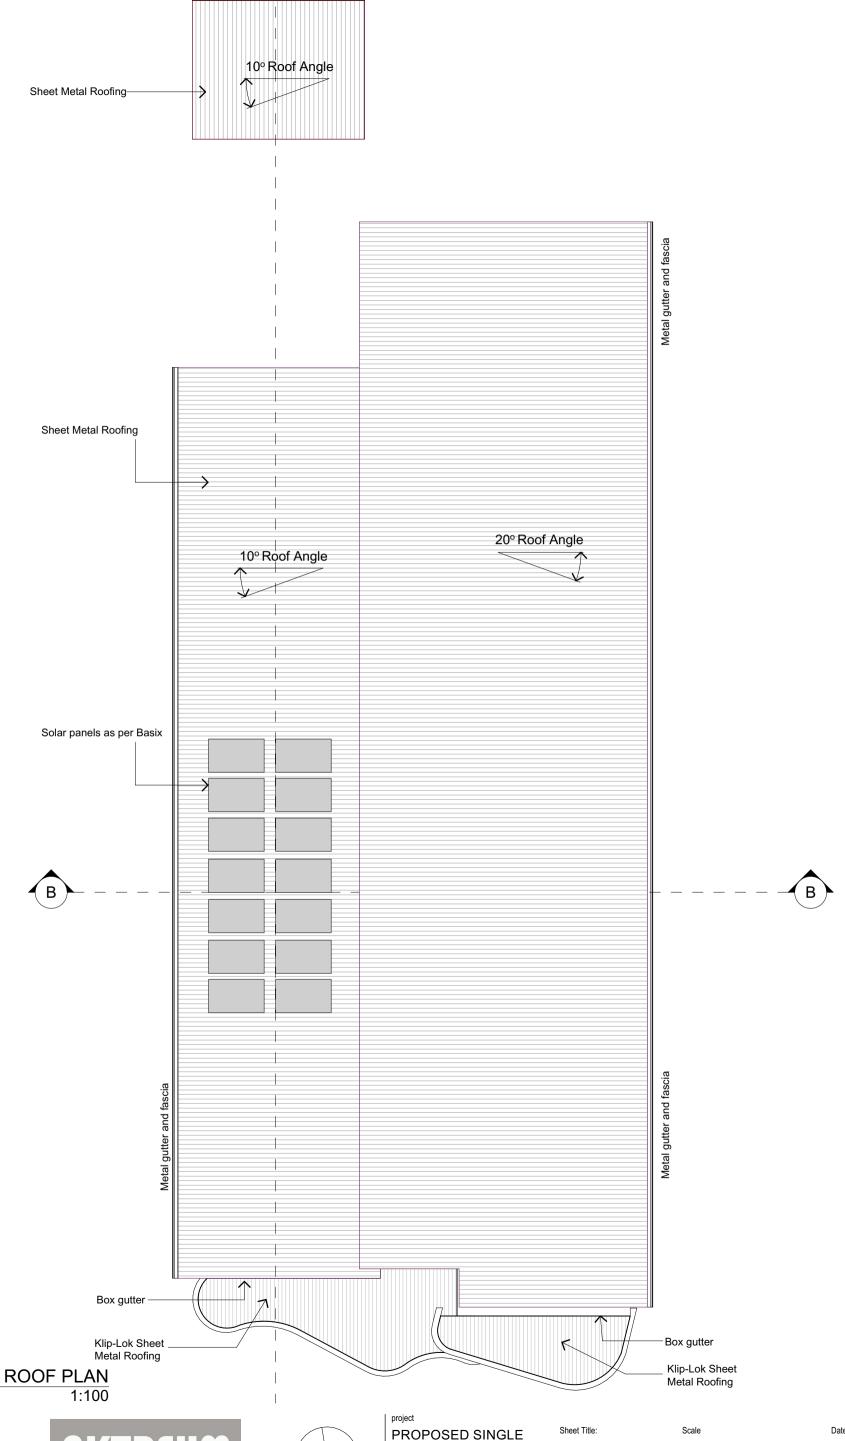




project					
PROPOSED SINGLE	Sheet Title:	Scale		Date/Revision	
STOREY DWELLING	FLOOR PLAN	1:100		22/05/24	
Client	Address	Issue	Drawing No.:	Sheet Number:	
Mr and Mrs Khadem	219 NOBLE AVENUE GREENACRE	С	219 nobleave	6	

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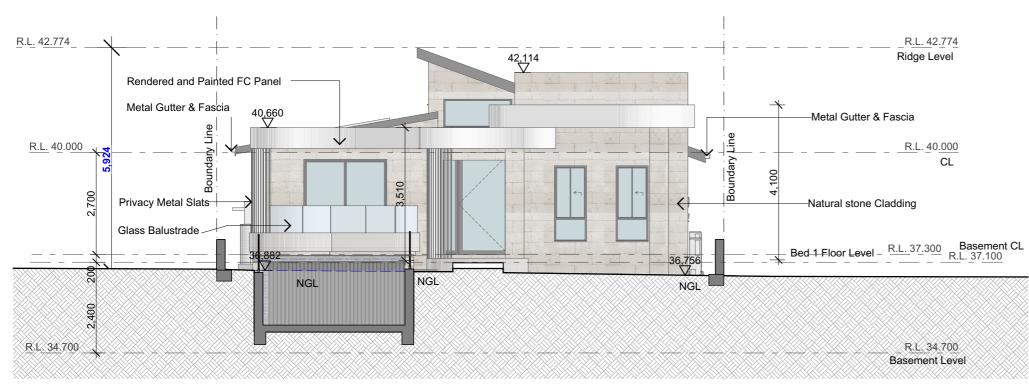










PROPOSED SINGLE STOREY DWELLING	Sheet Title: ROOF PLAN	Scale 1:100		Date/Revision 22/05/24
Client	Address	Issue	Drawing No.:	Sheet Number:
Mr and Mrs Khadem	219 NOBLE AVENUE GREENACRE	С	219 nobleave	7




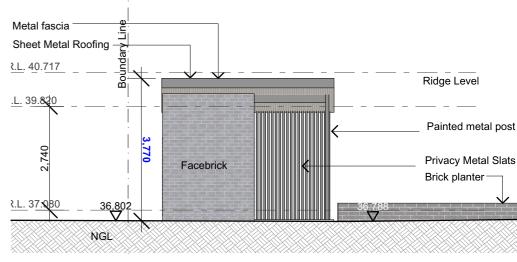

CABANA WEST ELEVATION

# WEST ELEVATION 1:100

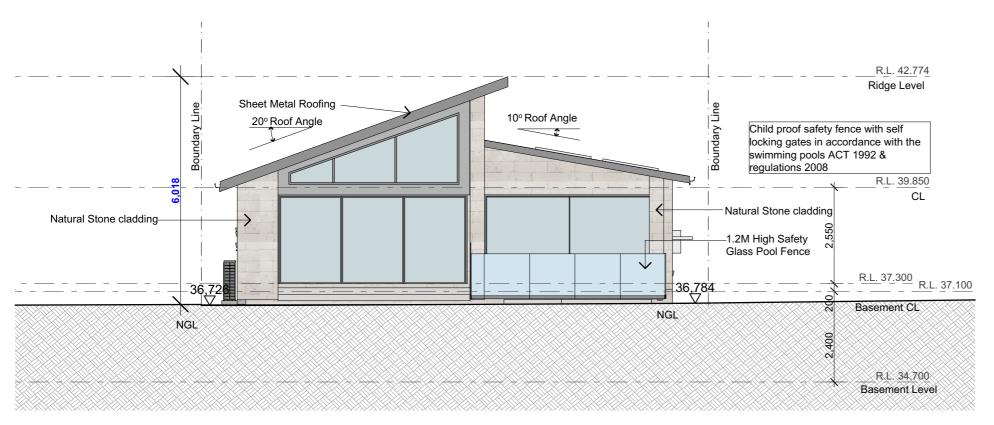

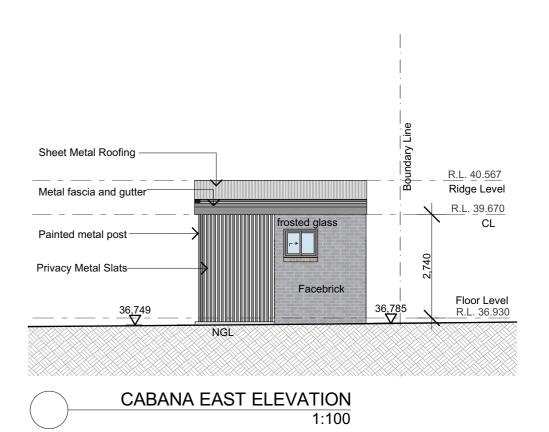


# EAST ELEVATION 1:100

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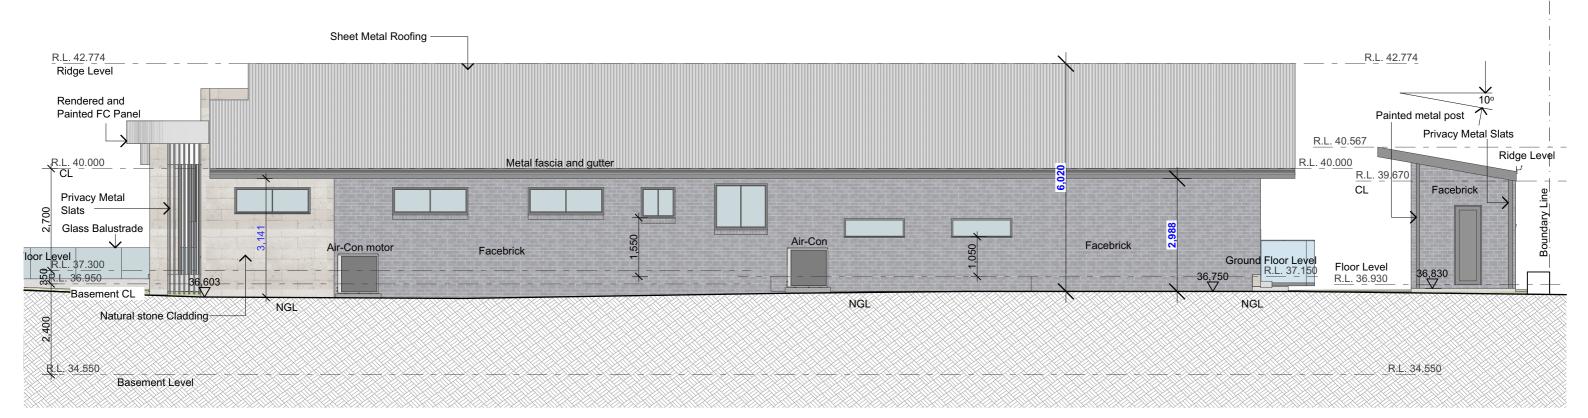


PROPOSED SINGLE STOREY DWELLING		Sheet Title:	ELEVATIONS	Drawing No.:	219 nobleave
Client	Address	Scale	1:100	Date/Revision	23/05/24
Mr and Mrs Khadem	219 NOBLE AVENUE GREENACRE	Issue	С	Sheet Numbe	er: 8

Quality of Work: All work carried out must comply with: Building Code of Australia to the extent required under Environmental Planning Assessment Act 1979, all other relevant codes, standards and specifications that the work is required to comply with under any law and the conditions of any relevant development consent or complying development certificate and any construction certificate.

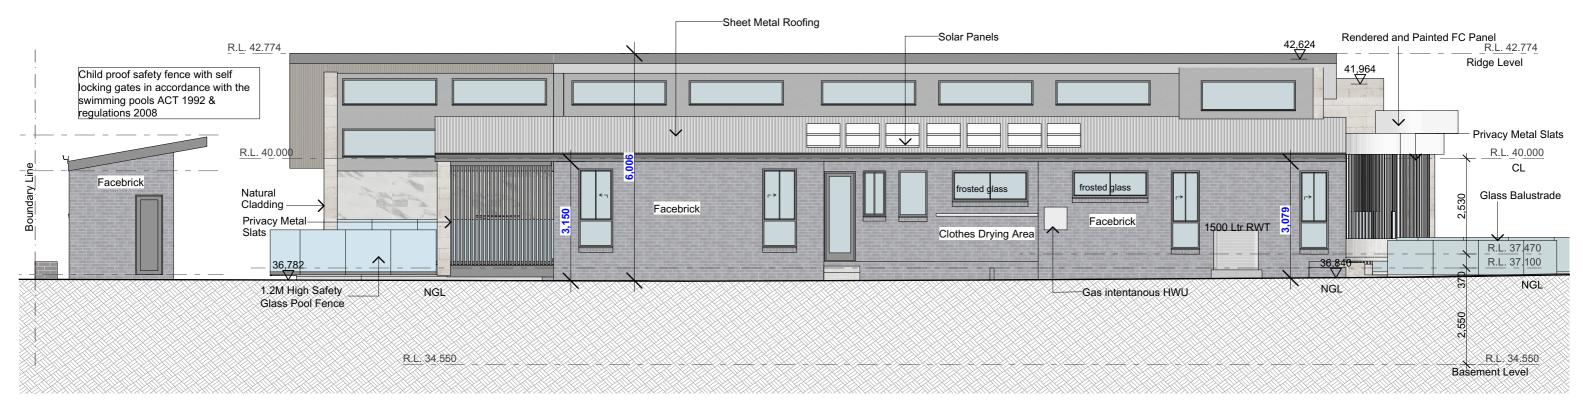

# NORTH ELEVATION 1:100





# SOUTH ELEVATION 1:100

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PROPOSED SINGLE STOREY DWELLING		Sheet Title:	ELEVATIONS	Drawing No.: 219 nobleave
Client	Address	Scale	1:100	Date/Revision 23/05/24
Mr and Mrs Khadem	219 NOBLE AVENUE GREENACRE	Issue	С	Sheet Number: 9



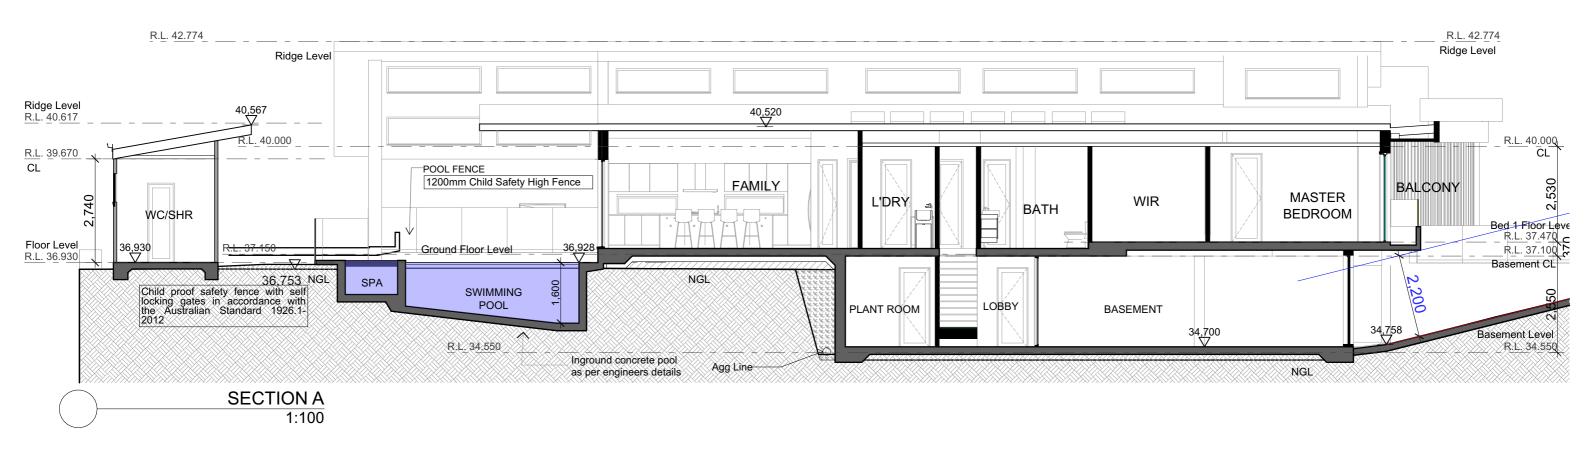

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PROPOSED SINGL	E STOREY DWELLING	Sheet Title:	SECTIONS	Drawing No.: 219 nobleave
Client	Address	Scale	1:100	Date/Revision 23/05/24
Mr and Mrs Khadem	219 NOBLE AVENUE GREENACRE	Issue	С	Sheet Number: 10
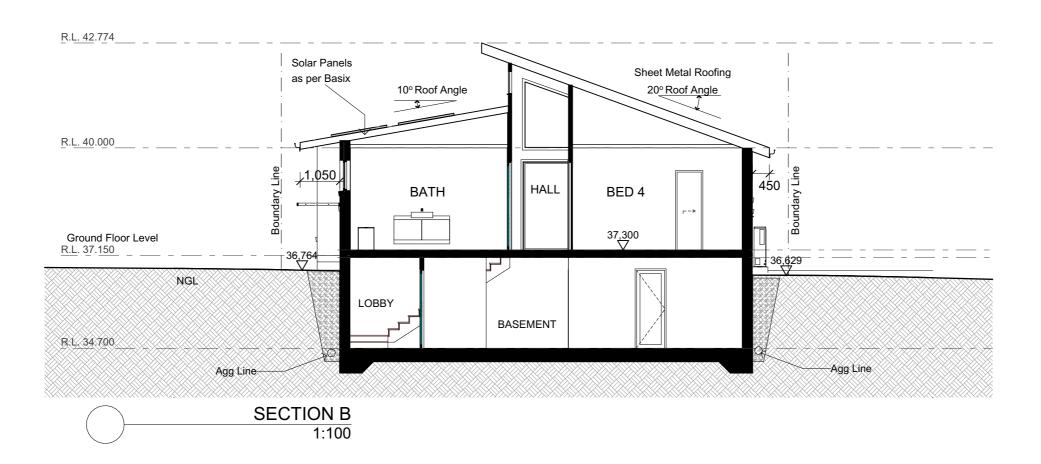
# Single Dwelling

Water Commitments	Thermal Performance and Materials commitments	The applicant must install a window and/or skylight in 2 bathroom(s)/toilet(s) in the development for natural lighting.	
Fixtures	Glazed windows, doors and skylights	Swimming pool	
The applicant must install showerheads with a minimum rating of 4 star (> 4.5 but <= 6 L/min plus spray force and/or coverage tests) in all showers in the development.	The applicant must install the windows, glazed doors and shading devices described in the table below, in accordance with the specifications listed in the table. Relevant overshadowing specifications must be satisfied for each glazed window and door.	The applicant must install the following heating system for the swimming pool in the development (or alternatively must not install an heating system for the swimming pool): solar only	
The applicant must install a toilet flushing system with a minimum rating of 5 star in each toilet in the development.	The dwelling may have 1 skylight (<0.7 square metres) which is not listed in the table.	The applicant must install the following pump for the swimming pool in the development, or a pump with a higher energy rating: mul speed with a performance of 7 stars.	
The applicant must install taps with a minimum rating of 6 star in the kitchen in the development.	The following requirements must also be satisfied in relation to each window and glazed door:	The applicant must install a timer for the swimming pool pump in the development.	
The applicant must install basin taps with a minimum rating of 6 star in each bathroom in the development.	The applicant must install windows and glazed doors in accordance with the height and width, frame and glazing types listed in the table.	Outdoor spa	
Alternative water	Each window and glazed door must have a U- value no greater than that listed and a Solar Heat Gain Coefficient (SHGC) within the range listed. Total system U values and SHGC must be calculated in accordance with National Fenestration Rating Council (NFRC)	The development must not incorporate any heating system for the spa.	
Rainwater tank	conditions.  The applicant must install the skylights described in the table below, in accordance with the specifications listed in the table. Total	The applicant must install a timer for the spa pump in the development.	
The applicant must install a rainwater tank of at least 1500 litres on the site. This rainwater tank must meet, and be installed in accordance with, the requirements of all applicable regulatory authorities.	skylight area must not exceed 3 square metres (the 3 square metre limit does not include the optional additional skylight of less than 0.7 square metres that does not have to be listed in the table).	Alternative energy	
The applicant must configure the rainwater tank to collect rain runoff from at least 300 square metres of the roof area of the development (excluding the area of the roof which drains to any stormwater tank or private dam).	Energy Commitments	The applicant must install a photovoltaic system as part of the development. The applicant must connect this system to the development's electrical system.	
The applicant must connect the rainwater tank to:	Hot water	The photovolatic system must consist of:	
all toilets in the development	The applicant must install the following hot water system in the development, or a system with a higher energy rating: gas	<ul> <li>photovolatic collectors with the capacity to generate at least 5 peak kilowatts of electricity, installed at an angle between 10 degrees and 25 degrees to the horizontal facing north</li> </ul>	
<ul> <li>at least one outdoor tap in the development (Note: NSW Health does not recommend that rainwater be used for human consumption in areas with potable water supply.)</li> </ul>	instantaneous with a performance of 7 stars.	Other	
Swimming Pool	Cooling system  The applicant must install the following cooling system, or a system with a higher energy rating, in at least 1 living area: 1-phase	The applicant must install a gas cooktop & electric oven in the kitchen of the dwelling.  The applicant must install a fixed outdoor clothes drying line as part of the development.	
The swimming pool must not have a volume greater than 18 kilolitres.	airconditioning - ducted; Energy rating: EER 3.0 - 3.5		
	The applicant must install the following cooling system, or a system with a higher energy rating, in at least 1 bedroom: 1-phase airconditioning - ducted; Energy rating: EER 3.0 - 3.5		
The swimming pool must have a pool cover.	Heating system	Thermal Performance and Materials commitments	
The swimming pool must be shaded.	The applicant must install the following heating system, or a system with a higher energy rating, in at least 1 living area: 1-phase	Ceiling fans	
	airconditioning - ducted; Energy rating: EER 3.0 - 3.5	The applicant must install at least one ceiling fan in at least one daytime habitable space, such as living room.	
The swimming pool must be outdoors.	The applicant must install the following heating system, or a system with a higher energy rating, in at least 1 bedroom: 1-phase		
Outdoor Spa	airconditioning - ducted; Energy rating: EER 3.0 - 3.5	The minimum number and diameter of ceiling fans in a daytime habitable space must be installed in accordance with the ABCB Housing Provisions (Part 13.5.2) of the National Construction Code .	
The spa must not have a volume greater than 2.5 kilolitres.	Ventilation		
	The applicant must install the following exhaust systems in the development:		
The spa must have a spa cover.	At least 1 Bathroom: individual fan, ducted to façade or roof; Operation control: manual on / timer off		
The spa must be shaded.	Kitchen: individual fan, ducted to façade or roof; Operation control: manual on / timer off		
Thermal Performance and Materials commitments	Laundry: individual fan, ducted to façade or roof; Operation control: manual on / timer off		
Do-it-yourself Method	Artificial lighting		
General features	The applicant must ensure that a minimum of 80% of light fixtures are fitted with fluorescent, compact fluorescent, or light-emitting-diode (LED) lamps.	_	
The dwelling must be a Class 1 dwelling according to the National Construction Code, and must not have more than 2 storeys.	Natural lighting		

**NCC COMPLIANCE** Works must comply with NCC 2022 (sheets 3 & 6

references the NCC 2019)

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The applicant must construct the floor(s), walls, and ceiling/roof of the dwelling in accordance with the specifications listed in the table The applicant must adopt one of the options listed in the tables below to address thermal bridging in metal framed floor(s), walls and

The applicant must show through receipts that the materials purchased for construction are consistent with the specifications listed in

The dwelling must not contain open mezzanine area exceeding 25 square metres.

The dwelling must not contain third level habitable attic room.

the tables below.





Client

PROPOSED SINGLE STOREY DWELLING Sheet Title: BASIX COMMITMENTS

Drawing No.: 219 nobleave

219 NOBLE AVENUE Mr and Mrs Khadem GREENACRE


Issue

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23/05/24

Sheet Number: 11



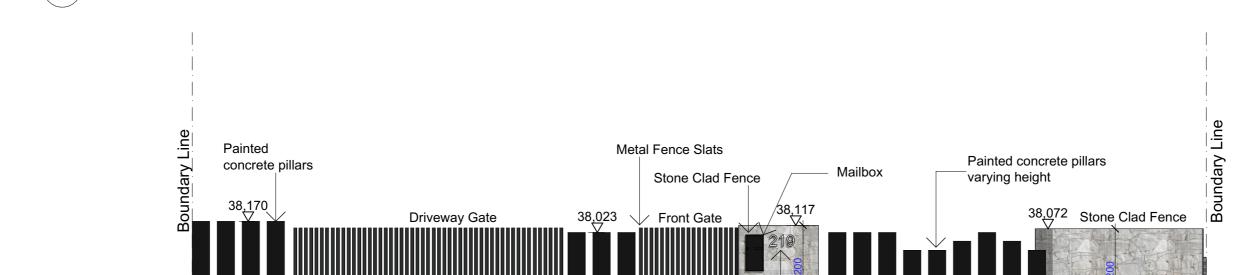

House Number

FD Fence Detail 1:50


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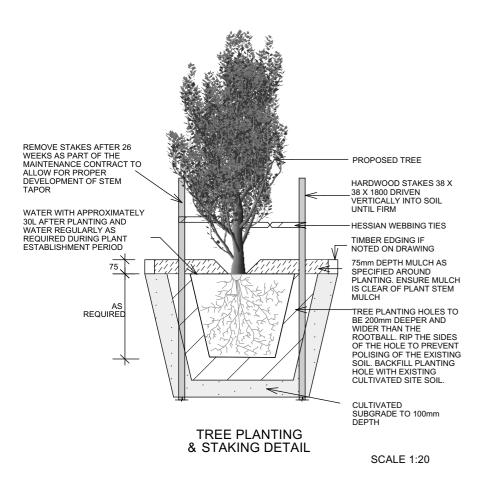
project PROPOSED SINGLE	STOREY DWELLING	Sheet Title:	STREETSCAPE & FENCE DETAIL	Drawing No.: 219 nobleave
Client	Address	Scale	1:50	Date/Revision 23/05/24
Mr and Mrs Khadem	219 NOBLE AVENUE GREENACRE	Issue	С	Sheet Number: 12


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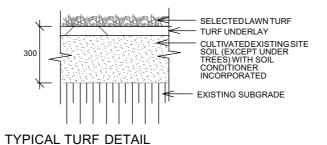
# LANDSCAPE DETAILS




DO NOT SCALE




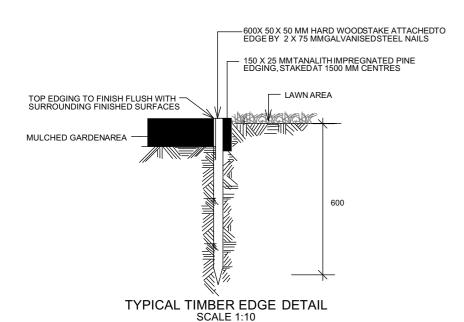

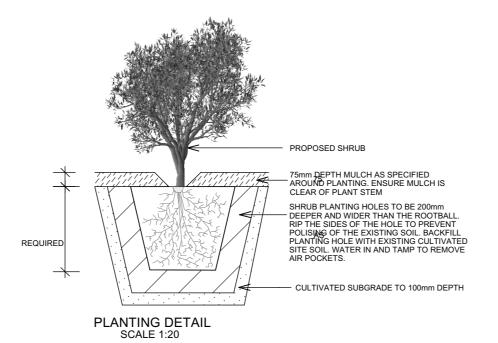

**SCALE 1:20** 

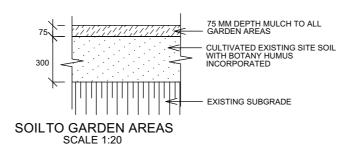

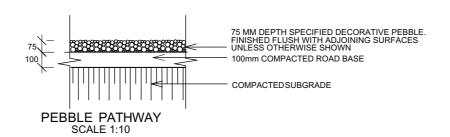

# **SOFTWORKS NOTES**

### GARDEN EDGING

- -Garden edging to be brick payer, steel or timber as specified
- -Brick edging to laid on a sand/cement mortar bed and haunched around the edges.
- -Bricks to be laid length-ways unless otherwise specified
- -Steel to be 5 x 75mm w/ rods welded in-situe every 1.2m
- -Timber to be treated pine w/ hardwood pegs screwed every 1.2m

### **GARDEN BEDS**

- -Garden beds to have organic garden mix cultivated into site soil
- -Imported soil to be free of weeds and toxins
- -Excavate holes for plants twice the size of the plants root ball
- -Ensure to remove pots from plants prior to installation
- -Trees to be staked and tied as required (refer to tree detail if required)
- -Water plants after planting
- -Install selected mulch to a depth between 50-75mm
- -Keep mulch free from touching the stem of the plant
- -Plant material showing poor signs of health, poor root to shoot ratio and any signs of pest & diseases or weed infestation should be rejected
- -Mulch & garden material is to be kept clear of house slab due to Termguard requirements

### LAWN

- -Grade areas of lawn removing large stones, rocks & sticks
- -Install drainage lines as required and grade lawn toward stormwater pits
- -Spread out a high quality top soil mix to a thickness of 75-100mm
- -Screen soil to the desired levels & grades
- -Roll out selected turf (to be selected by client)
- -Water well after installation

# IRRIGATION

- -All garden beds and planter boxes to have irrigation installed
- -Irrigation layout, pipe & fittings to be nominated by qualified tradesperson
- -Irrigation to be installed by qualified tradesperson
- -Irrigation system to be run as per installers recommendations


# PLANT ESTABLISHMENT/MAINTENANCE PERIOD

Regular maintenance is to be carried out, including the following works:

- -Watering-to maintain healthy growth, adjusted on regular basis to suit seasons
- -Weeding to all garden and lawn areas
- -Pest and disease control
- -Trim hedge plantings to maintain desired heights
- -Tip pruning as required and fertilising to species recommendations
- -Mowing and edging of all turfed areas

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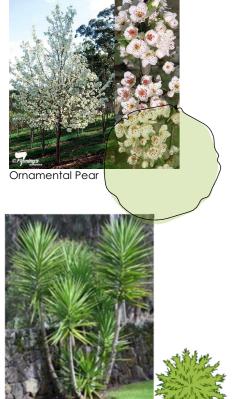



PROPOSED SINGLE STOREY DWELLING Sheet Title: LANDSCAPE NOTES AND DETAILS

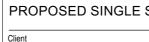Drawing No.: 219 nobleave 23/05/24

219 NOBLE AVENUE Mr and Mrs Khadem GREENACRE

Issue C Sheet Number: 13



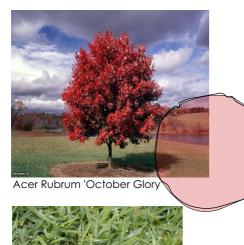

**Buffalo Sir Walte** 

Fountain Grass





Spanish Lavender





RED WOODCHIP MULCH

DENOTES GRASS AREA DENOTES PERMEABLE No. 219 PEBBLE BASE PROPOSED SINGLE STOREY DWELLING WITH BASEMENT **DENOTES TIMBER AIR-CON MOTOR** BARK 00, FFL: 37.30 00 67 90° 42.

FFL.+37.47

BALCONY

SWIMMING POOL

Clivea Miniara

Magnolia Little Gem

Buffalo grass

Permeable Paving

River pebble 20mm

Elephantipes

Buffalo grass

Acer Rubrum October Glory

thorrhoea

and lawn bedding

\_88⊡ . .‱.

× KERB & GUTTER

AIR-CON MOTOR

and lawn bedding

LOT 2 DP 400523

ALERESCO FFL. 37.19

572.3 m<sup>2</sup>





xanthorrhoed glauca

Magnolia Little Gem

Yucca Elephantipes

**Latin Name Common Name** Pot Size Mature Size Quantity Grevillea 500mm 21 Blue Chalk Sticks 200mm 900mm 300mm 8 Oleander Cordyline-Narda Acmena Smitthii Minor 45Ltr 7 Lilly Pili 5.0m Fountain Grass Pennisetum Alopecuroides 200mm 1000mm 5 Spanish Lavender Lavandula Stoechas 200mm 600mm 11 117m<sup>2</sup> **Buffalo Sir Walter** Xanthorrhoea glauca Grass tree 200mm 2m 6 9 Pennisetum Setaceum Purpureum Purple Fountain 200mm 1000mm 200mm 1000mm Lavandula angustifolia Lavender 3 RED WOODCHIP MULCH 88m<sup>2</sup> 15 Spanish Lavender Lavandula Stoechas 200mm 600mm

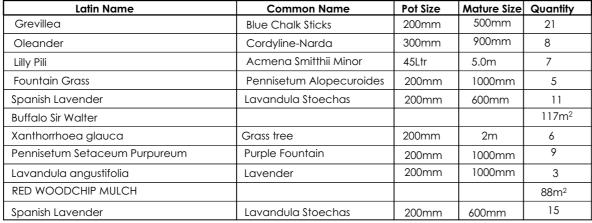

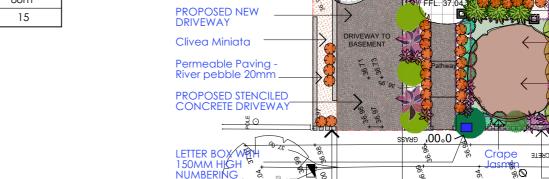

rapernaemontana-

**Denotes Pool** 

Child proof safety fence

Fence

1.2M High Safety Glass Pool Fence

Permeable Paving River pebble 20mm

FOLDABLE WALL MOUNTED CLOTHES LINE

INSTANTANEOUS

**HWU AS PER BASIX** 

1500 Ltr "Ultraslim" A/G Rainwater

LOCKABLE GATE

GARBAGE BINS

яэттиэ & вяях







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PROPOSED SINGLE STOREY DWELLING					
Client	Address				
Mr and Mrs Khadem	219 NOBLE AVENUE GREENACRE				


1:200

LANDSCAPE PLAN

Drawing No.: 219 nobleave CONCEPT LANDSCAPE PLAN 1:200 23/05/24 Sheet Number: 14 C

BENCHMARK

NOBLE RL 36.91 AVENUE

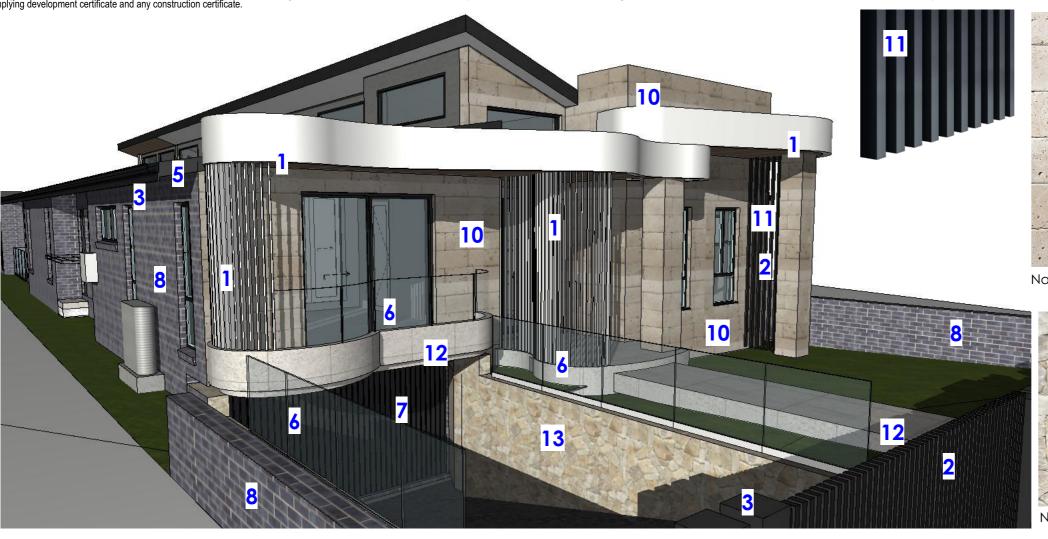



Natural Stone - Limestone wall caldding



Natural Stone - Limestone wall caldding

Travertine - Silver white non slip exterior tiles




Dulux: Snowy Mountains Half




Dulux: Black Anodised aluminium



Dulux: Monument

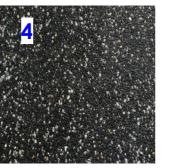

Exposed aggregate with Corrugated Netal Roof-white crushed stone driveway Color Bond Windspray and crossover sealed finish

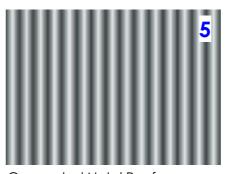



Austral Bricks - Metalic 2



FRAMELESS GLASS BALUSTRADES AND POOL SAFETY FENCE


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As selected panel lift garage doors

Client



Dulux - Mid Grey textured

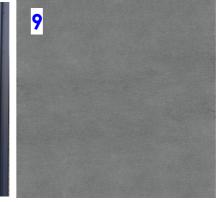

DULUX BLACK CAVIAR OR SIMILAR - MAIN ENTRY DOOR AND FRAME

PROPOSED SINGLE STOREY DWELLING Sheet Title: COLOURS & FINISHES SCHEDULE

**GREENACRE** 

1:200 219 NOBLE AVENUE Mr and Mrs Khadem

С

23/05/24 Sheet Number: 15

Drawing No.: 219 nobleave

ID	W01	W02	W03	W04		W05	W06	W07	W08	W09	W10		W11
W x H Size	850×2,000	850×2,000	750×2,060	750×2,060	2,00	00×700	2,000×800	750×1,200	600×1,200	900×2,060	900×2,060		4,500×2,350
3D Front View	<b>*</b> 7	<b>€</b> ¬	  ->	  ->					r	F>	<b>*</b> 7		
Window List													
ID		V	V12 W13	W14	W15	W16	W1	17	W18	W19	W20	W21	W22
W x H Size		5,000×1,	900 1,600×500	1,600×500	1,400×1,200	900×800	2,000×70	2,0	00×700	2,000×700	1,800×750	2,500×800	2,500×650
3D Front View			_										
ID	v	V23	W24	W25	W26	V	/27	W28	W30	W30	W	/31	W32
W x H Size	2,500×0				2,500×650	2,500×7		500×702	2,500×750	900×750	2,500×7		4,500×1,900
3D Front View													

# WINDOW SCHEDULE 1:1

Door List								
ID	ID D01		D03	D04	D04			
W x H Size	1,800×2,700	2,200×2,350	4,000×2,350	5,000×2,350	820×2,350			
3D Front View		<b>r-→</b>		<b>←</b> -¬ <b>←</b> -¬				

DOOR SCHEDULE
1:1

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	Client	Address	Scale	1:1	Date/Revision	23/05/24
	Mr and Mrs Khadem	219 NOBLE AVENUE GREENACRE	Issue	С	Sheet Number:	16